

平面図 S=1:2500


| 点名 | X座標 | Y座標 | Z座標 | 点名 | X座標 | Y座標 | Z座標 | 点名 | X座標 | Y座標 | Z座標 | 点名 | X座標 | Y座標 | Z座標 |
|------------|-----------|-----------|--------|------------|-----------|-----------|-------|------------|-----------|-----------|-------|------------|-----------|-----------|--------|
| 0K275.36 | 82353.631 | 95752.390 | 8.325 | 1K300.26 | 83189.002 | 96189.315 | 7.206 | 0K275.390 | 82443.070 | 95719.002 | 6.535 | 1K300.285 | 83146.444 | 96159.812 | 7.150 |
| 0K300.43 | 82353.079 | 95769.206 | 8.887 | 1K325.14 | 83188.926 | 96185.767 | 4.674 | 0K300.47 | 82438.510 | 95744.113 | 7.206 | 1K325.24 | 83164.226 | 96136.889 | 6.175 |
| 0K325.47 | 82356.411 | 95794.847 | 9.906 | 1K350.25.3 | 83213.480 | 96190.034 | 7.288 | 0K325.37 | 82436.640 | 95769.960 | 6.694 | 1K350.23.5 | 83180.778 | 96122.812 | 6.345 |
| 0K350.56.6 | 82360.538 | 95811.781 | 11.112 | 1K375.36 | 83230.549 | 96144.566 | 7.599 | 0K350.39 | 82441.077 | 95794.945 | 6.191 | 1K375.23 | 83197.713 | 96108.197 | 6.539 |
| 0K375.59 | 82370.749 | 95854.499 | 11.269 | 1K400 | 83247.258 | 96129.400 | 7.209 | 0K375.28.9 | 82454.907 | 95826.965 | 5.923 | 1K400 | 83214.404 | 96093.299 | 7.294 |
| 1K400 | 82392.034 | 95886.079 | 6.287 | 1K425.27.5 | 83264.752 | 96115.707 | 7.618 | 0K400 | 82462.152 | 95851.228 | 5.985 | 1K425.24.5 | 83229.055 | 96077.110 | 7.530 |
| 0K425.32.5 | 82430.212 | 95884.812 | 2.388 | 1K450.27.5 | 83281.351 | 96100.721 | 7.679 | 0K425.32 | 82477.724 | 95841.190 | 6.017 | 1K450.26 | 83245.498 | 96061.611 | 7.625 |
| 0K450.30 | 82450.945 | 95905.711 | 2.487 | 1K475.27 | 83297.196 | 96086.649 | 7.708 | 0K450.30 | 82491.557 | 95868.545 | 5.989 | 1K475.27.5 | 83262.442 | 96044.698 | 7.455 |
| 0K475.29.5 | 82469.461 | 95919.059 | 2.477 | 1K500.26 | 83315.532 | 96096.508 | 7.799 | 0K475.27 | 82507.705 | 95897.469 | 5.994 | 1K500.28 | 83274.954 | 96031.771 | 7.555 |
| 0K500.28 | 82488.965 | 95932.365 | 3.409 | 1K525.26 | 83336.747 | 96093.117 | 7.874 | 0K500.25.5 | 82526.857 | 95927.269 | 5.987 | 1K525.26 | 83290.635 | 96016.741 | 7.728 |
| 0K525.29 | 82501.281 | 95951.843 | 3.446 | 1K550.27.5 | 83358.897 | 96082.658 | 8.078 | 0K525.26.5 | 82543.599 | 95951.934 | 6.021 | 1K550.26.5 | 83304.024 | 96002.618 | 8.175 |
| 0K550.26 | 82516.499 | 95971.321 | 3.980 | 1K575.26.5 | 83383.000 | 96071.185 | 8.235 | 0K550.27 | 82559.960 | 95984.442 | 6.028 | 1K575.23.1 | 83319.290 | 95985.925 | 8.820 |
| 0K575.29 | 82527.943 | 95994.034 | 7.794 | 1K600 | 83407.423 | 96065.033 | 7.913 | 0K575.26.5 | 82577.083 | 96022.301 | 6.199 | 1K600 | 83336.327 | 95969.133 | 8.191 |
| 1K600 | 82546.785 | 96018.411 | 7.288 | 1K625.26.5 | 83427.059 | 96057.491 | 7.982 | 1K600 | 82597.020 | 95997.923 | 6.257 | 1K625.25.5 | 83345.171 | 95947.422 | 8.269 |
| 0K625.29.7 | 82566.694 | 96027.220 | 6.842 | 1K650.27.5 | 83448.629 | 96048.322 | 8.040 | 0K625.31 | 82610.690 | 96008.177 | 6.290 | 1K650.25.5 | 83354.017 | 95928.839 | 8.419 |
| 0K650.27 | 82611.252 | 96038.325 | 6.184 | 1K675.26.5 | 83470.269 | 96039.182 | 8.074 | 0K650.28 | 82624.016 | 95976.826 | 6.321 | 1K675.25.5 | 83367.058 | 95910.255 | 8.495 |
| 0K675.26.4 | 82639.376 | 96052.905 | 6.265 | 1K700.26 | 83492.294 | 96030.319 | 8.108 | 0K675.26.5 | 82644.788 | 95989.282 | 6.307 | 1K700.25.5 | 83379.495 | 95891.671 | 8.545 |
| 0K700.26.2 | 82663.944 | 96063.231 | 6.320 | 1K725.26 | 83516.532 | 96020.848 | 8.126 | 0K700.26 | 82669.302 | 95998.304 | 6.239 | 1K725.25 | 83392.344 | 95873.263 | 8.787 |
| 0K725.26 | 82688.522 | 96072.356 | 6.342 | 1K750.26 | 83541.471 | 96010.619 | 8.129 | 0K725.26.5 | 82693.921 | 95983.261 | 6.223 | 1K750.25.5 | 83405.293 | 95853.202 | 9.429 |
| 0K750.25.7 | 82713.150 | 96089.784 | 6.340 | 1K775.31 | 83566.259 | 95996.732 | 8.217 | 0K750.27 | 82718.539 | 95989.361 | 7.454 | 1K775.26 | 83425.517 | 95836.889 | 9.865 |
| 0K775.26.5 | 82737.636 | 96103.106 | 7.483 | 1K800 | 83591.523 | 95983.344 | 8.188 | 0K775.27 | 82743.107 | 95989.887 | 7.666 | 1K800 | 83442.011 | 95817.048 | 10.490 |
| 1K800 | 82759.620 | 96114.554 | 7.126 | 1K825.33.5 | 83616.169 | 95972.667 | 8.299 | 0K800 | 82770.281 | 95993.870 | 7.565 | 1K825.33.5 | 83462.492 | 95798.711 | 10.695 |
| 0K825.35 | 82783.919 | 96129.160 | 6.519 | 1K850.32 | 83641.741 | 95961.122 | 8.228 | 0K825.36.5 | 82794.450 | 95998.748 | 7.025 | 1K850.32 | 83482.581 | 95779.400 | 10.944 |
| 0K850.27 | 82801.670 | 96145.449 | 6.540 | 1K875.31 | 83666.574 | 95950.031 | 8.247 | 0K850.25 | 82823.722 | 96007.356 | 5.840 | 1K875.30 | 83502.921 | 95759.292 | 11.497 |
| 0K875.26 | 82824.459 | 96164.015 | 6.619 | 1K900.26.5 | 83692.155 | 95938.659 | 8.235 | 0K875.26 | 82846.511 | 96016.923 | 5.673 | 1K900.28 | 83523.361 | 95740.783 | 12.327 |
| 0K900.25.5 | 82843.354 | 96172.760 | 6.657 | 1K925.29 | 83718.002 | 95927.204 | 8.215 | 0K900.24.5 | 82871.111 | 96021.172 | 5.527 | 1K925.27 | 83546.039 | 95721.219 | 13.444 |
| 1K900.25.5 | 82862.087 | 96185.308 | 6.743 | 1K950.29 | 83743.456 | 95916.964 | 8.209 | 0K925.35 | 82898.115 | 96026.523 | 5.573 | 1K950.27 | 83569.499 | 95701.969 | 14.421 |
| 0K925.24.5 | 82882.088 | 96199.941 | 6.776 | 1K975.26.5 | 83769.131 | 95906.159 | 8.215 | 0K950.25 | 82912.712 | 96030.662 | 5.670 | 1K975.27.5 | 83596.554 | 95684.294 | 15.407 |
| 0K975.25 | 82901.881 | 96215.367 | 6.874 | 1K1000 | 83800.446 | 95895.529 | 8.491 | 0K975.25 | 82932.300 | 96037.691 | 5.977 | 1K1000 | 83627.025 | 95671.238 | 16.430 |
| 1K1000 | 82921.783 | 96229.465 | 6.709 | 2K025.36.5 | 83826.467 | 95883.902 | 8.659 | 1K1000 | 82956.906 | 96049.135 | 6.691 | 2K025.38.5 | 83659.888 | 95651.970 | 17.571 |
| 2K025.35.5 | 82938.920 | 96244.403 | 6.976 | 2K050.33 | 83857.438 | 95872.264 | 8.719 | 1K1025.28 | 82971.475 | 96061.951 | 6.607 | 2K050.29.5 | 83692.490 | 95638.988 | 18.702 |
| 1K1025.35 | 82956.665 | 96258.012 | 7.452 | 2K075.30 | 83884.090 | 95861.963 | 8.747 | 1K1050.29 | 82986.440 | 96073.973 | 6.116 | 2K075.25 | 83724.623 | 95624.308 | 19.837 |
| 1K1075.26 | 82974.106 | 96272.019 | 7.673 | 2K100.26 | 83909.488 | 95851.925 | 8.823 | 1K1075.31 | 83001.628 | 96081.790 | 6.153 | 2K100.28 | 83757.694 | 95611.432 | 20.968 |
| 1K1100.29 | 82997.645 | 96286.868 | 7.669 | 2K125.24.5 | 83931.730 | 95841.607 | 8.936 | 1K1100.33 | 83021.971 | 96103.609 | 6.302 | 2K125.26.5 | 83794.828 | 95597.318 | 22.107 |
| 1K125.22.3 | 83020.397 | 96292.603 | 6.950 | 2K150.24 | 83956.098 | 95832.565 | 8.954 | 1K125.23 | 83038.347 | 96121.611 | 5.944 | 2K150.27 | 83839.196 | 95584.276 | 23.249 |
| 1K150.26 | 83036.860 | 96299.089 | 7.010 | 2K175.25 | 83981.407 | 95823.343 | 8.981 | 1K150.25.5 | 83063.242 | 96135.082 | 6.082 | 2K175.30 | 83879.561 | 95571.994 | 24.391 |
| 1K175.24.5 | 83052.416 | 96315.072 | 6.901 | 2K200.26 | 84007.543 | 95814.909 | 9.063 | 1K175.31 | 83085.645 | 96150.618 | 6.918 | 2K200.29 | 83918.623 | 95559.273 | 25.532 |
| 1K200 | 83077.672 | 96326.587 | 6.652 | 2K225.24 | 84021.310 | 95806.622 | 9.063 | 1K200 | 83097.167 | 96162.594 | 6.998 | 2K225.26 | 83942.333 | 95546.238 | 26.673 |
| 1K225.28 | 83121.635 | 96340.951 | 7.030 | 2K250.24 | 84044.066 | 95798.168 | 9.147 | 1K225.27 | 83102.776 | 96171.726 | 7.032 | 2K250.27 | 83965.512 | 95533.996 | 27.814 |
| 1K250.29.5 | 83143.497 | 96352.643 | 7.106 | 2K275.25 | 84066.984 | 95790.487 | 9.208 | 1K250.31 | 83110.866 | 96170.487 | 7.165 | 2K275.27 | 83988.227 | 95521.575 | 28.955 |
| 1K275.26 | 83163.162 | 96364.039 | 7.129 | | | | | 1K275.27 | 83120.288 | 96184.121 | 7.266 | | | | |

施工延長 L=271m
 掘削 V=3040m3
 伐木除根 A=6700m2

当初設計図面

| | | | |
|------|----------------------------|------|-----|
| 工事名 | R2波土 北河内谷川 美波・北河内河床掘削工事(2) | | |
| 路線名等 | 北河内谷川 | | |
| 工事箇所 | 海部郡美波町北河内(第2分划) | | |
| 図面名 | 平面図 | 図面番号 | 1/7 |
| 縮尺 | S=1:2500 | 図面番号 | 1/7 |
| 会社名 | | | |
| 事業者名 | 徳島県南郡総合県民局土木整備部(美波) | | |

縦断面 V=1:250 H=1:2500

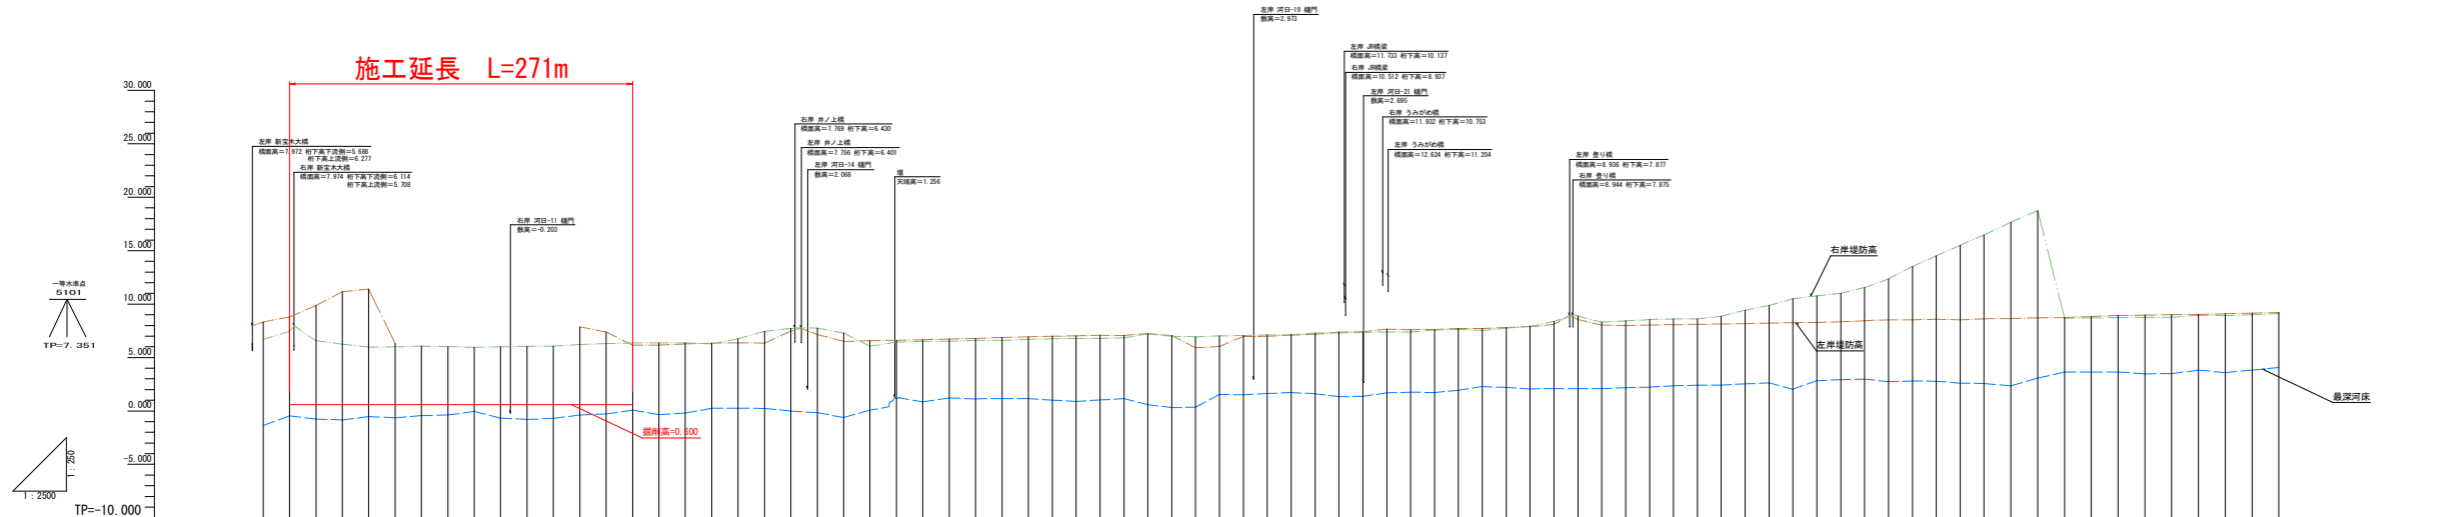


| 測 点 番 号 | 追加距離 | 最深河床高 | 左岸堤防高 | 右岸堤防高 | 計画管理河床高 | 平均河床高 | 勾配及び延長 |
|---------|--------|--------|--------|-------|---------|-------|--------|
| 0075 | 74.000 | -1.345 | 8.325 | 6.855 | | | |
| 0080 | 24.697 | -0.465 | 8.887 | 7.455 | | | |
| 0085 | 24.697 | -0.755 | 9.906 | 6.574 | | | |
| 0090 | 24.697 | -0.845 | 11.112 | 6.257 | | | |
| 0095 | 24.697 | -0.521 | 11.369 | 5.927 | | | |
| 0100 | 24.697 | -0.637 | 6.287 | 5.965 | | | |
| 0105 | 24.697 | -0.447 | 2.398 | 6.017 | | | |
| 0110 | 24.697 | -0.357 | 2.697 | 5.964 | | | |
| 0115 | 24.697 | -0.656 | 3.029 | 5.961 | | | |
| 0120 | 24.697 | -0.807 | 3.046 | 6.021 | | | |
| 0125 | 24.697 | -0.692 | 3.000 | 6.028 | | | |
| 0130 | 24.697 | -0.379 | 7.394 | 6.194 | | | |
| 0135 | 24.697 | -0.269 | 7.398 | 6.257 | | | |
| 0140 | 24.697 | 0.075 | 6.042 | 6.290 | | | |
| 0145 | 24.697 | -0.344 | 6.164 | 6.321 | | | |
| 0150 | 24.697 | -0.190 | 6.265 | 6.354 | | | |
| 0155 | 24.697 | 0.244 | 6.320 | 6.307 | | | |
| 0160 | 24.697 | 0.244 | 6.340 | 6.220 | | | |
| 0165 | 24.697 | 0.244 | 6.340 | 7.454 | | | |
| 0170 | 24.697 | 0.281 | 6.342 | 6.722 | | | |
| 0175 | 24.697 | 0.244 | 7.483 | 7.664 | | | |
| 0180 | 24.697 | -0.160 | 7.126 | 7.105 | | | |
| 0185 | 24.697 | -0.617 | 6.910 | 6.910 | | | |
| 0190 | 24.697 | 0.044 | 6.540 | 6.594 | | | |
| 0195 | 24.697 | 1.149 | 6.919 | 6.617 | | | |
| 0200 | 24.697 | 0.850 | 6.657 | 6.657 | | | |
| 0205 | 24.697 | 1.214 | 6.742 | 6.742 | | | |
| 0210 | 24.697 | 1.244 | 6.776 | 6.776 | | | |
| 0215 | 24.697 | 1.170 | 6.814 | 6.814 | | | |
| 0220 | 24.697 | 1.552 | 6.709 | 6.843 | | | |
| 0225 | 22.355 | 1.016 | 6.976 | 6.895 | | | |
| 0230 | 22.355 | 0.890 | 7.027 | 6.895 | | | |
| 0235 | 22.355 | 1.022 | 7.072 | 6.114 | | | |
| 0240 | 22.355 | 1.156 | 7.069 | 6.153 | | | |
| 0245 | 22.355 | 0.844 | 7.069 | 6.302 | | | |
| 0250 | 22.355 | 0.310 | 7.015 | 6.805 | | | |
| 0255 | 22.355 | 0.353 | 6.001 | 6.994 | | | |
| 0260 | 22.355 | 1.552 | 6.052 | 6.994 | | | |
| 0265 | 22.355 | 1.507 | 7.033 | 7.022 | | | |
| 0270 | 22.355 | 1.647 | 7.106 | 7.044 | | | |
| 0275 | 22.355 | 1.222 | 7.189 | 7.044 | | | |
| 0280 | 22.355 | 1.615 | 7.209 | 7.044 | | | |
| 0285 | 22.355 | 1.322 | 4.874 | 7.150 | | | |
| 0290 | 22.355 | 1.371 | 7.328 | 7.416 | | | |
| 0295 | 22.355 | 1.684 | 7.469 | 7.469 | | | |
| 0300 | 22.355 | 1.757 | 7.509 | 7.509 | | | |
| 0305 | 22.355 | 1.720 | 7.619 | 7.509 | | | |
| 0310 | 22.355 | 2.074 | 7.879 | 7.639 | | | |
| 0315 | 22.355 | 2.084 | 7.979 | 7.707 | | | |
| 0320 | 22.355 | 2.084 | 7.979 | 7.707 | | | |
| 0325 | 22.355 | 2.221 | 8.040 | 7.834 | | | |
| 0330 | 22.355 | 2.303 | 8.074 | 8.074 | | | |
| 0335 | 22.355 | 2.074 | 8.135 | 8.135 | | | |
| 0340 | 22.355 | 2.074 | 8.135 | 8.135 | | | |
| 0345 | 22.355 | 2.132 | 8.271 | 8.271 | | | |
| 0350 | 22.355 | 2.027 | 8.188 | 8.271 | | | |
| 0355 | 22.355 | 2.844 | 8.299 | 8.299 | | | |
| 0360 | 22.355 | 2.917 | 8.328 | 8.328 | | | |
| 0365 | 22.355 | 2.747 | 8.535 | 8.535 | | | |
| 0370 | 22.355 | 2.813 | 8.519 | 8.519 | | | |
| 0375 | 22.355 | 2.776 | 8.570 | 8.570 | | | |
| 0380 | 22.355 | 2.604 | 8.515 | 8.515 | | | |
| 0385 | 22.355 | 2.576 | 8.491 | 8.491 | | | |
| 0390 | 25.022 | 3.468 | 8.659 | 8.659 | | | |
| 0395 | 25.022 | 3.632 | 8.719 | 8.719 | | | |
| 0400 | 25.022 | 3.644 | 8.823 | 8.823 | | | |
| 0405 | 25.022 | 3.644 | 8.938 | 8.938 | | | |
| 0410 | 25.022 | 3.468 | 8.954 | 8.954 | | | |
| 0415 | 25.022 | 3.506 | 8.981 | 8.981 | | | |
| 0420 | 25.022 | 3.816 | 8.965 | 8.965 | | | |
| 0425 | 25.022 | 3.884 | 9.000 | 8.965 | | | |
| 0430 | 25.022 | 3.803 | 9.147 | 8.965 | | | |
| 0435 | 25.022 | 4.051 | 9.208 | 8.965 | | | |

当初設計図面

| | |
|------|-------------------------------|
| 工事名 | R-2 波士 北河内谷川 奥波・北河内河床掘削工事 (2) |
| 路線名称 | 北河内谷川 |
| 工事箇所 | 海部郡奥波町北河内 (第2分割) |
| 図面名 | 河川縦断面図 |
| 縮尺 | V=1:250 H=1:2500 |
| 図面番号 | 2/7 |
| 会社名 | |
| 事業者名 | 徳島県南河内総合振興局土木課 (奥波) |

横断図 S=1:250

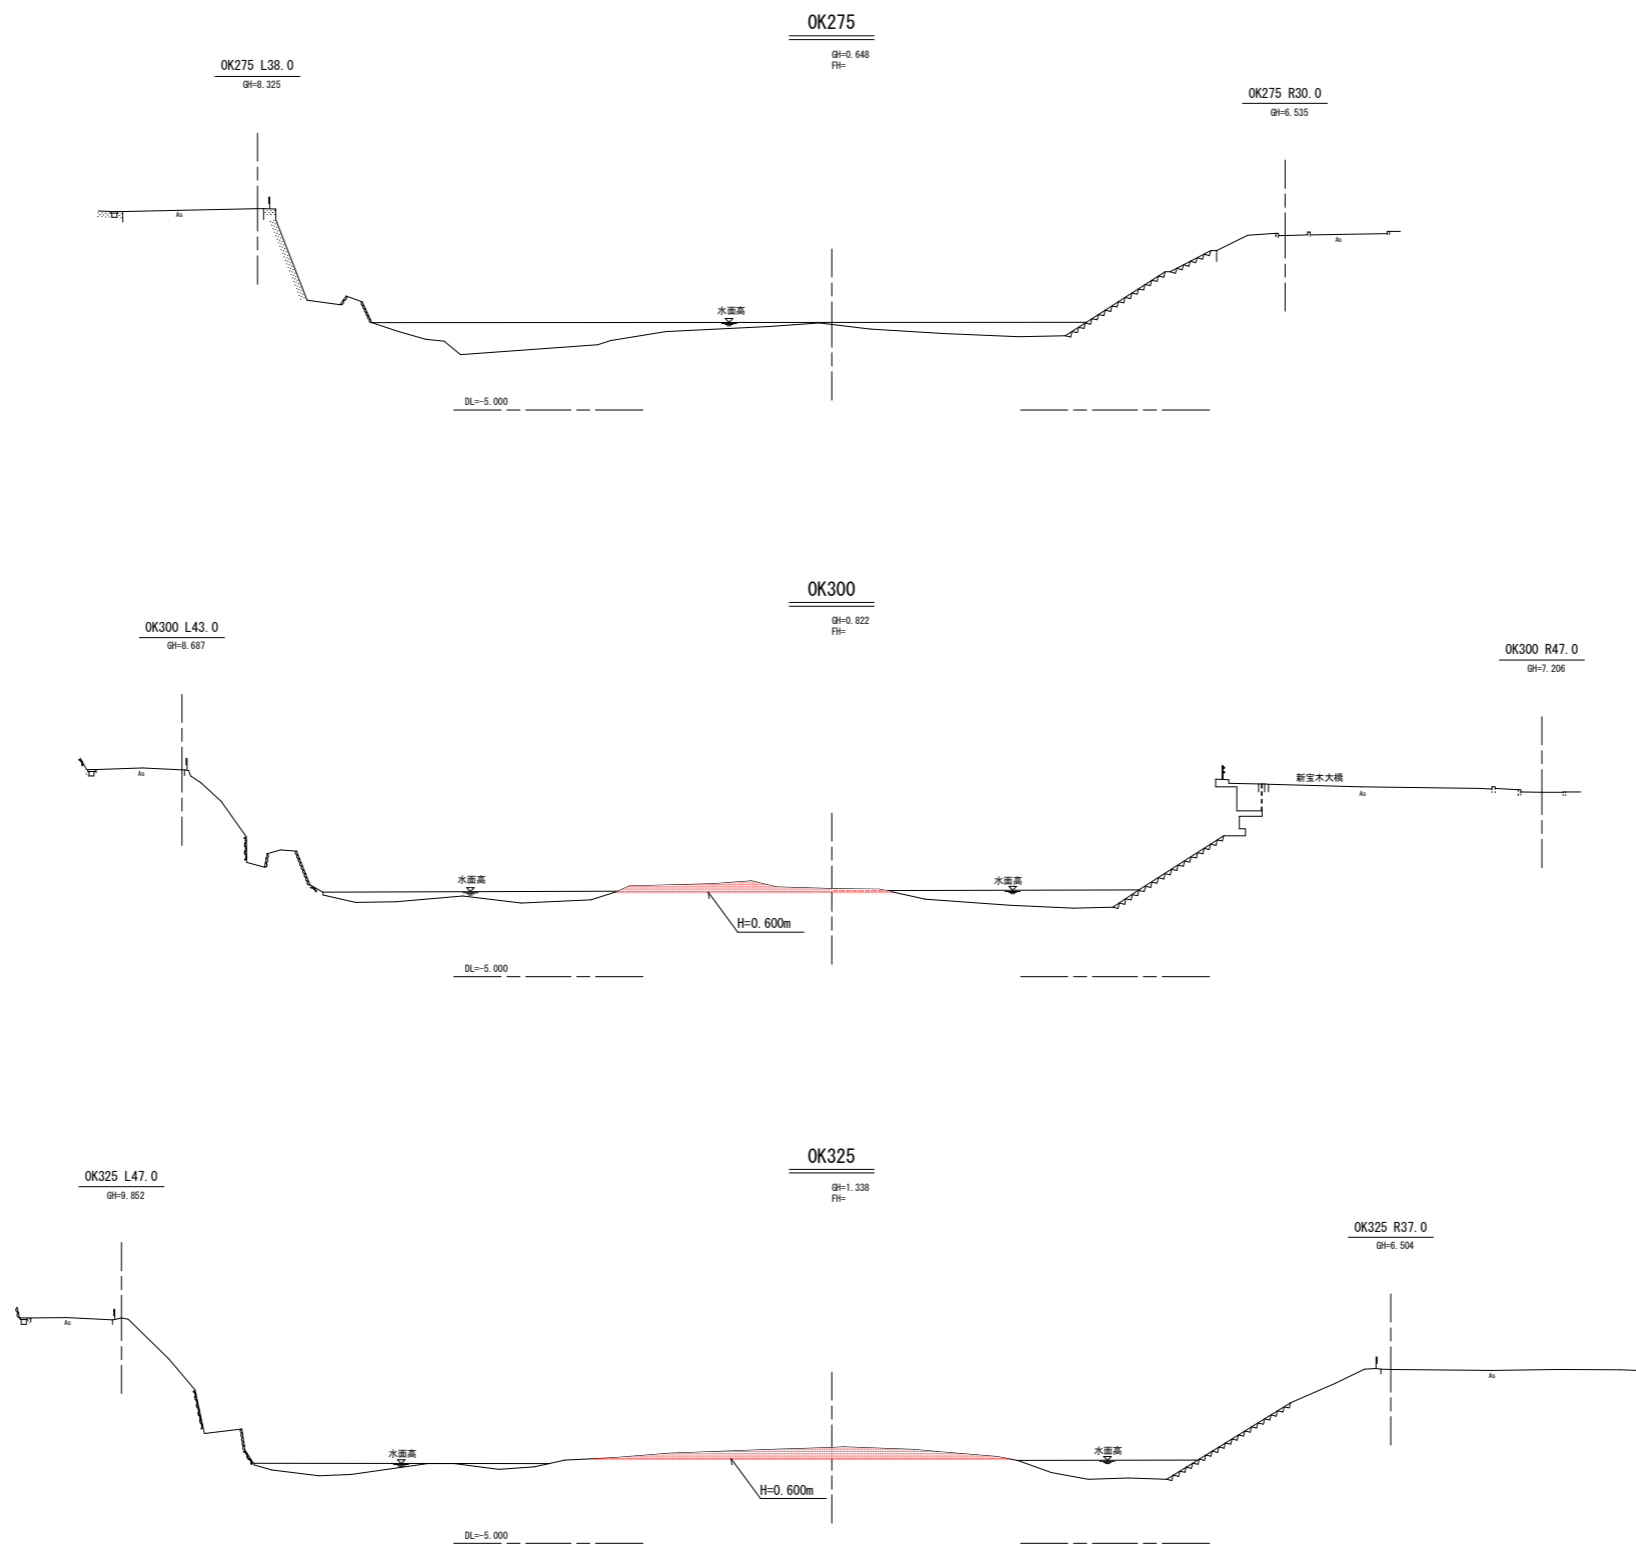


掘削 6.86m²

掘削 12.45m²

当初設計図面

| | | | |
|-------------|----------------------------|------|-----|
| OK275~OK325 | | | |
| 工事名 | R2波土 北河内谷川 美波・北河内河床掘削工事(2) | | |
| 路線名等 | 北河内谷川 | | |
| 工事箇所 | 海部郡美波町北河内(第2分割) | | |
| 図面名 | 横断面図1 | | |
| 縮尺 | S=1:250 | 図面番号 | 3/7 |
| 会社名 | | | |
| 事業者名 | 徳島県南部総合県民局県土整備部(美波) | | |


横断面図 S=1:250

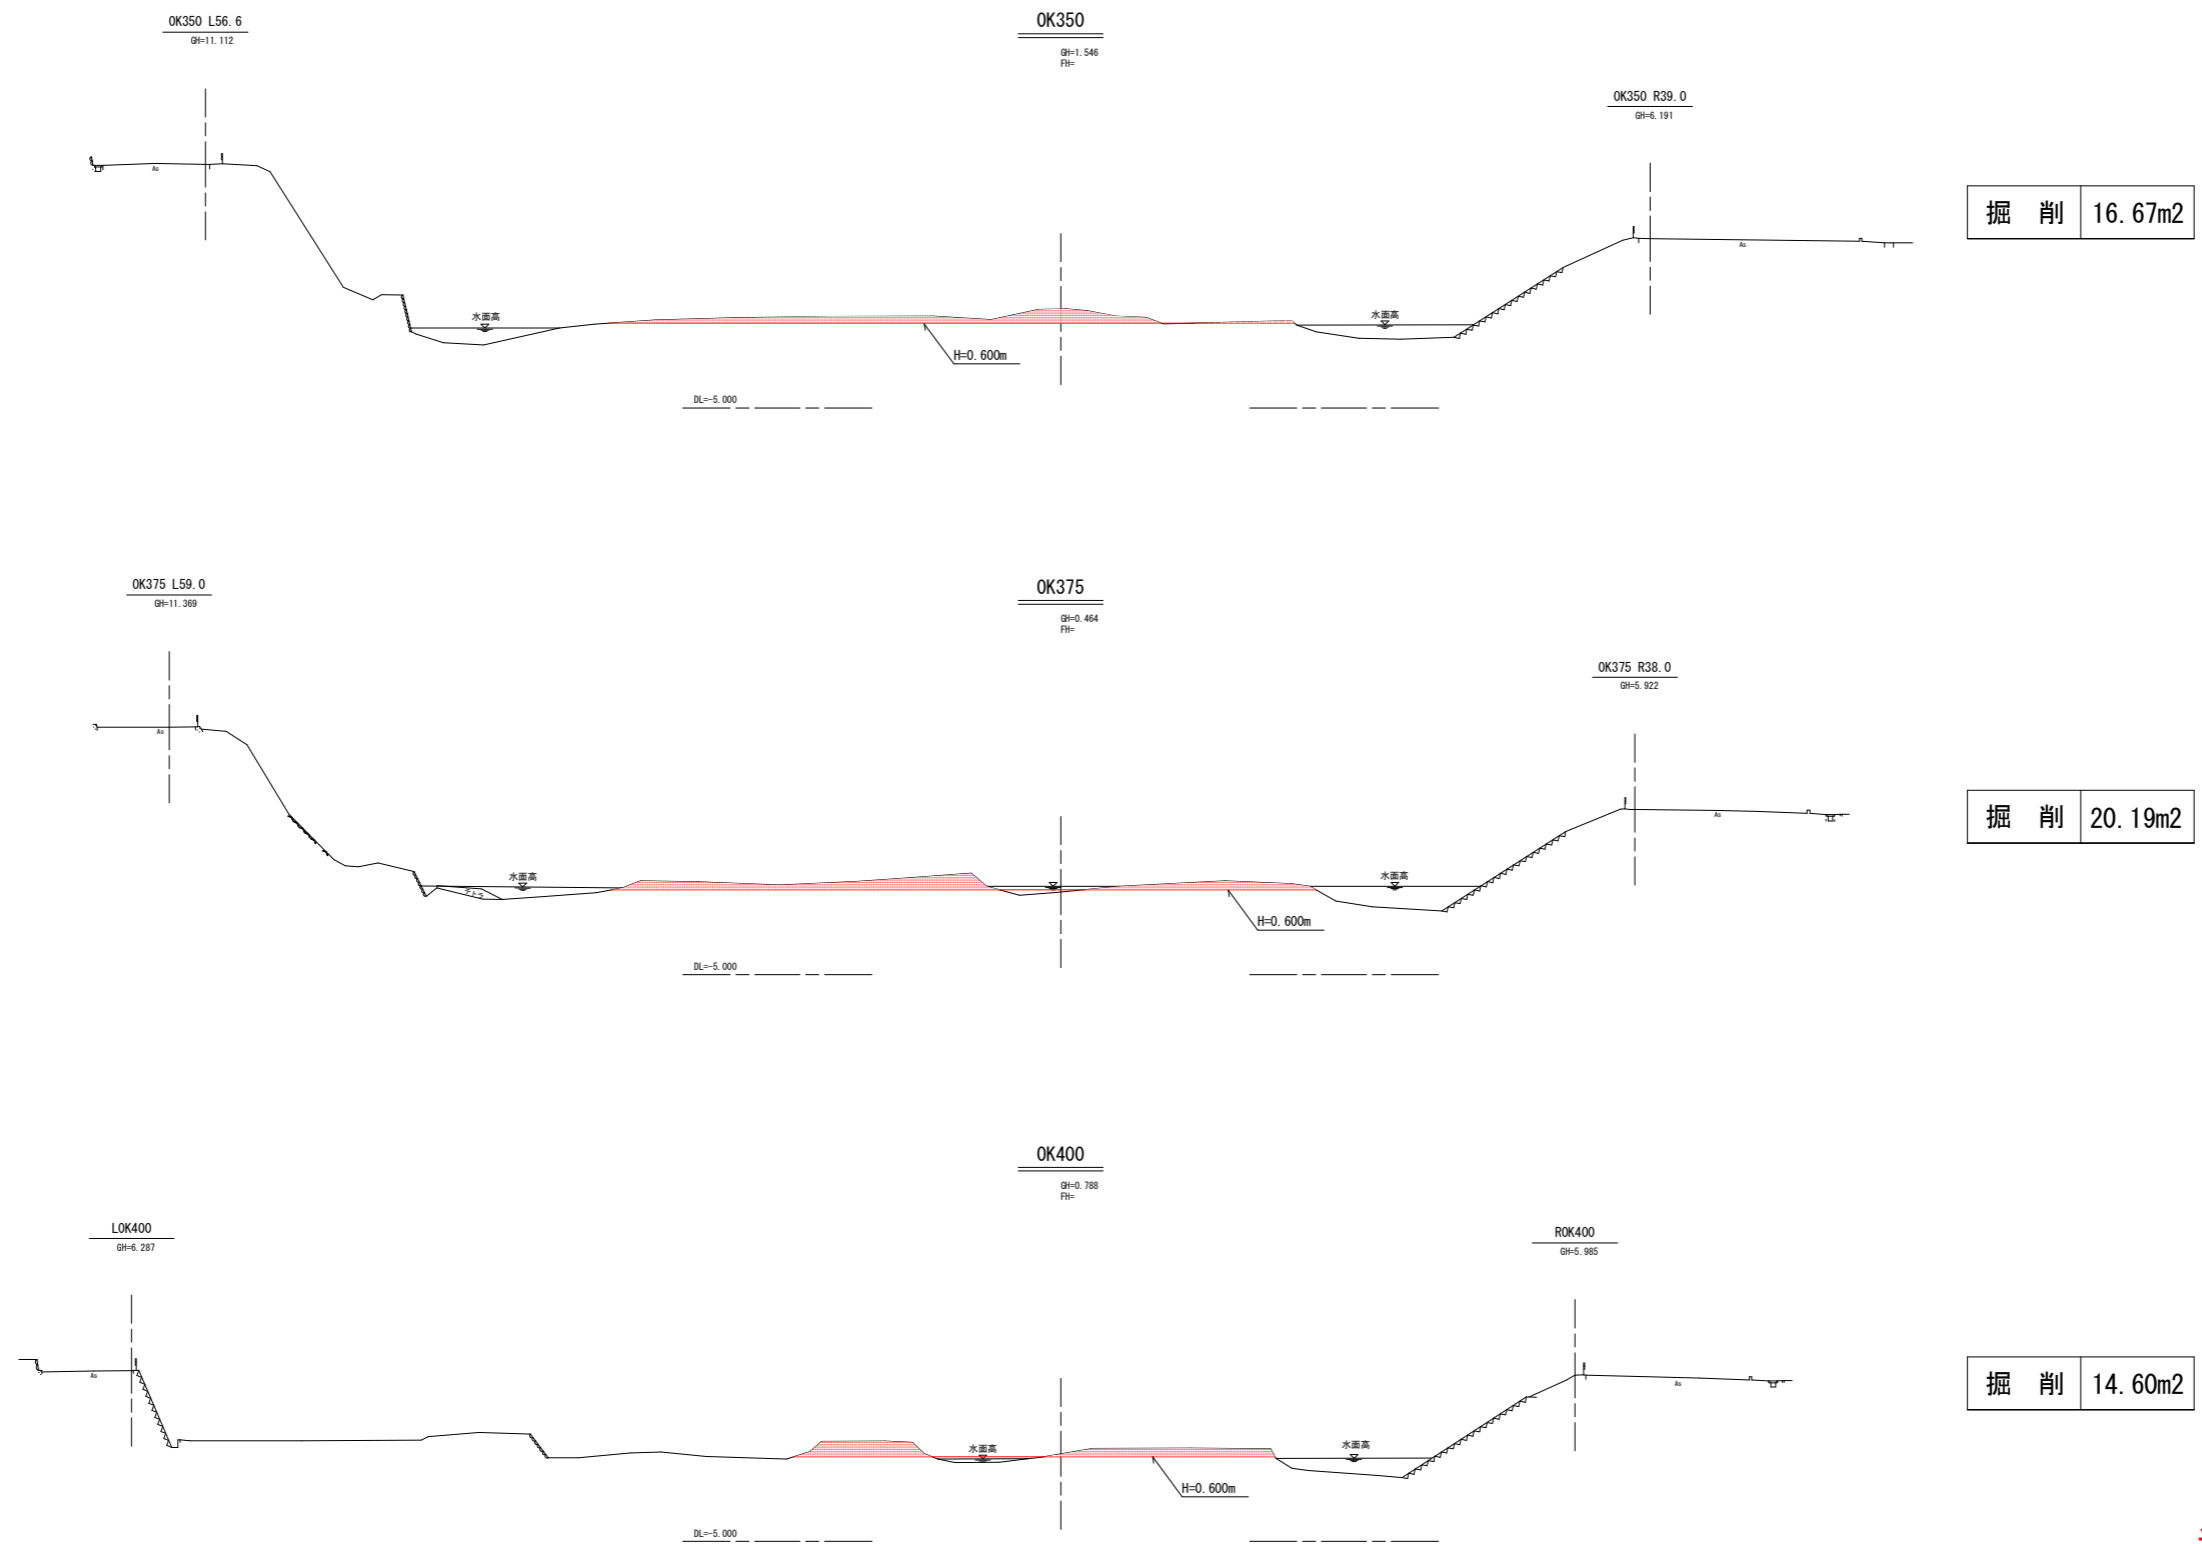

当初設計図面

| OK350~OK400 | | | |
|-------------|----------------------------|------|-----|
| 工事名 | R2波土 北河内谷川 美波・北河内河床掘削工事(2) | | |
| 路線名等 | 北河内谷川 | | |
| 工事箇所 | 海部郡美波町北河内(第2分割) | | |
| 図面名 | 横断面図2 | | |
| 縮尺 | S=1:250 | 図面番号 | 4/7 |
| 会社名 | | | |
| 事業者名 | 徳島県南部総合県民局県土整備部(美波) | | |







横断面図 S=1:250

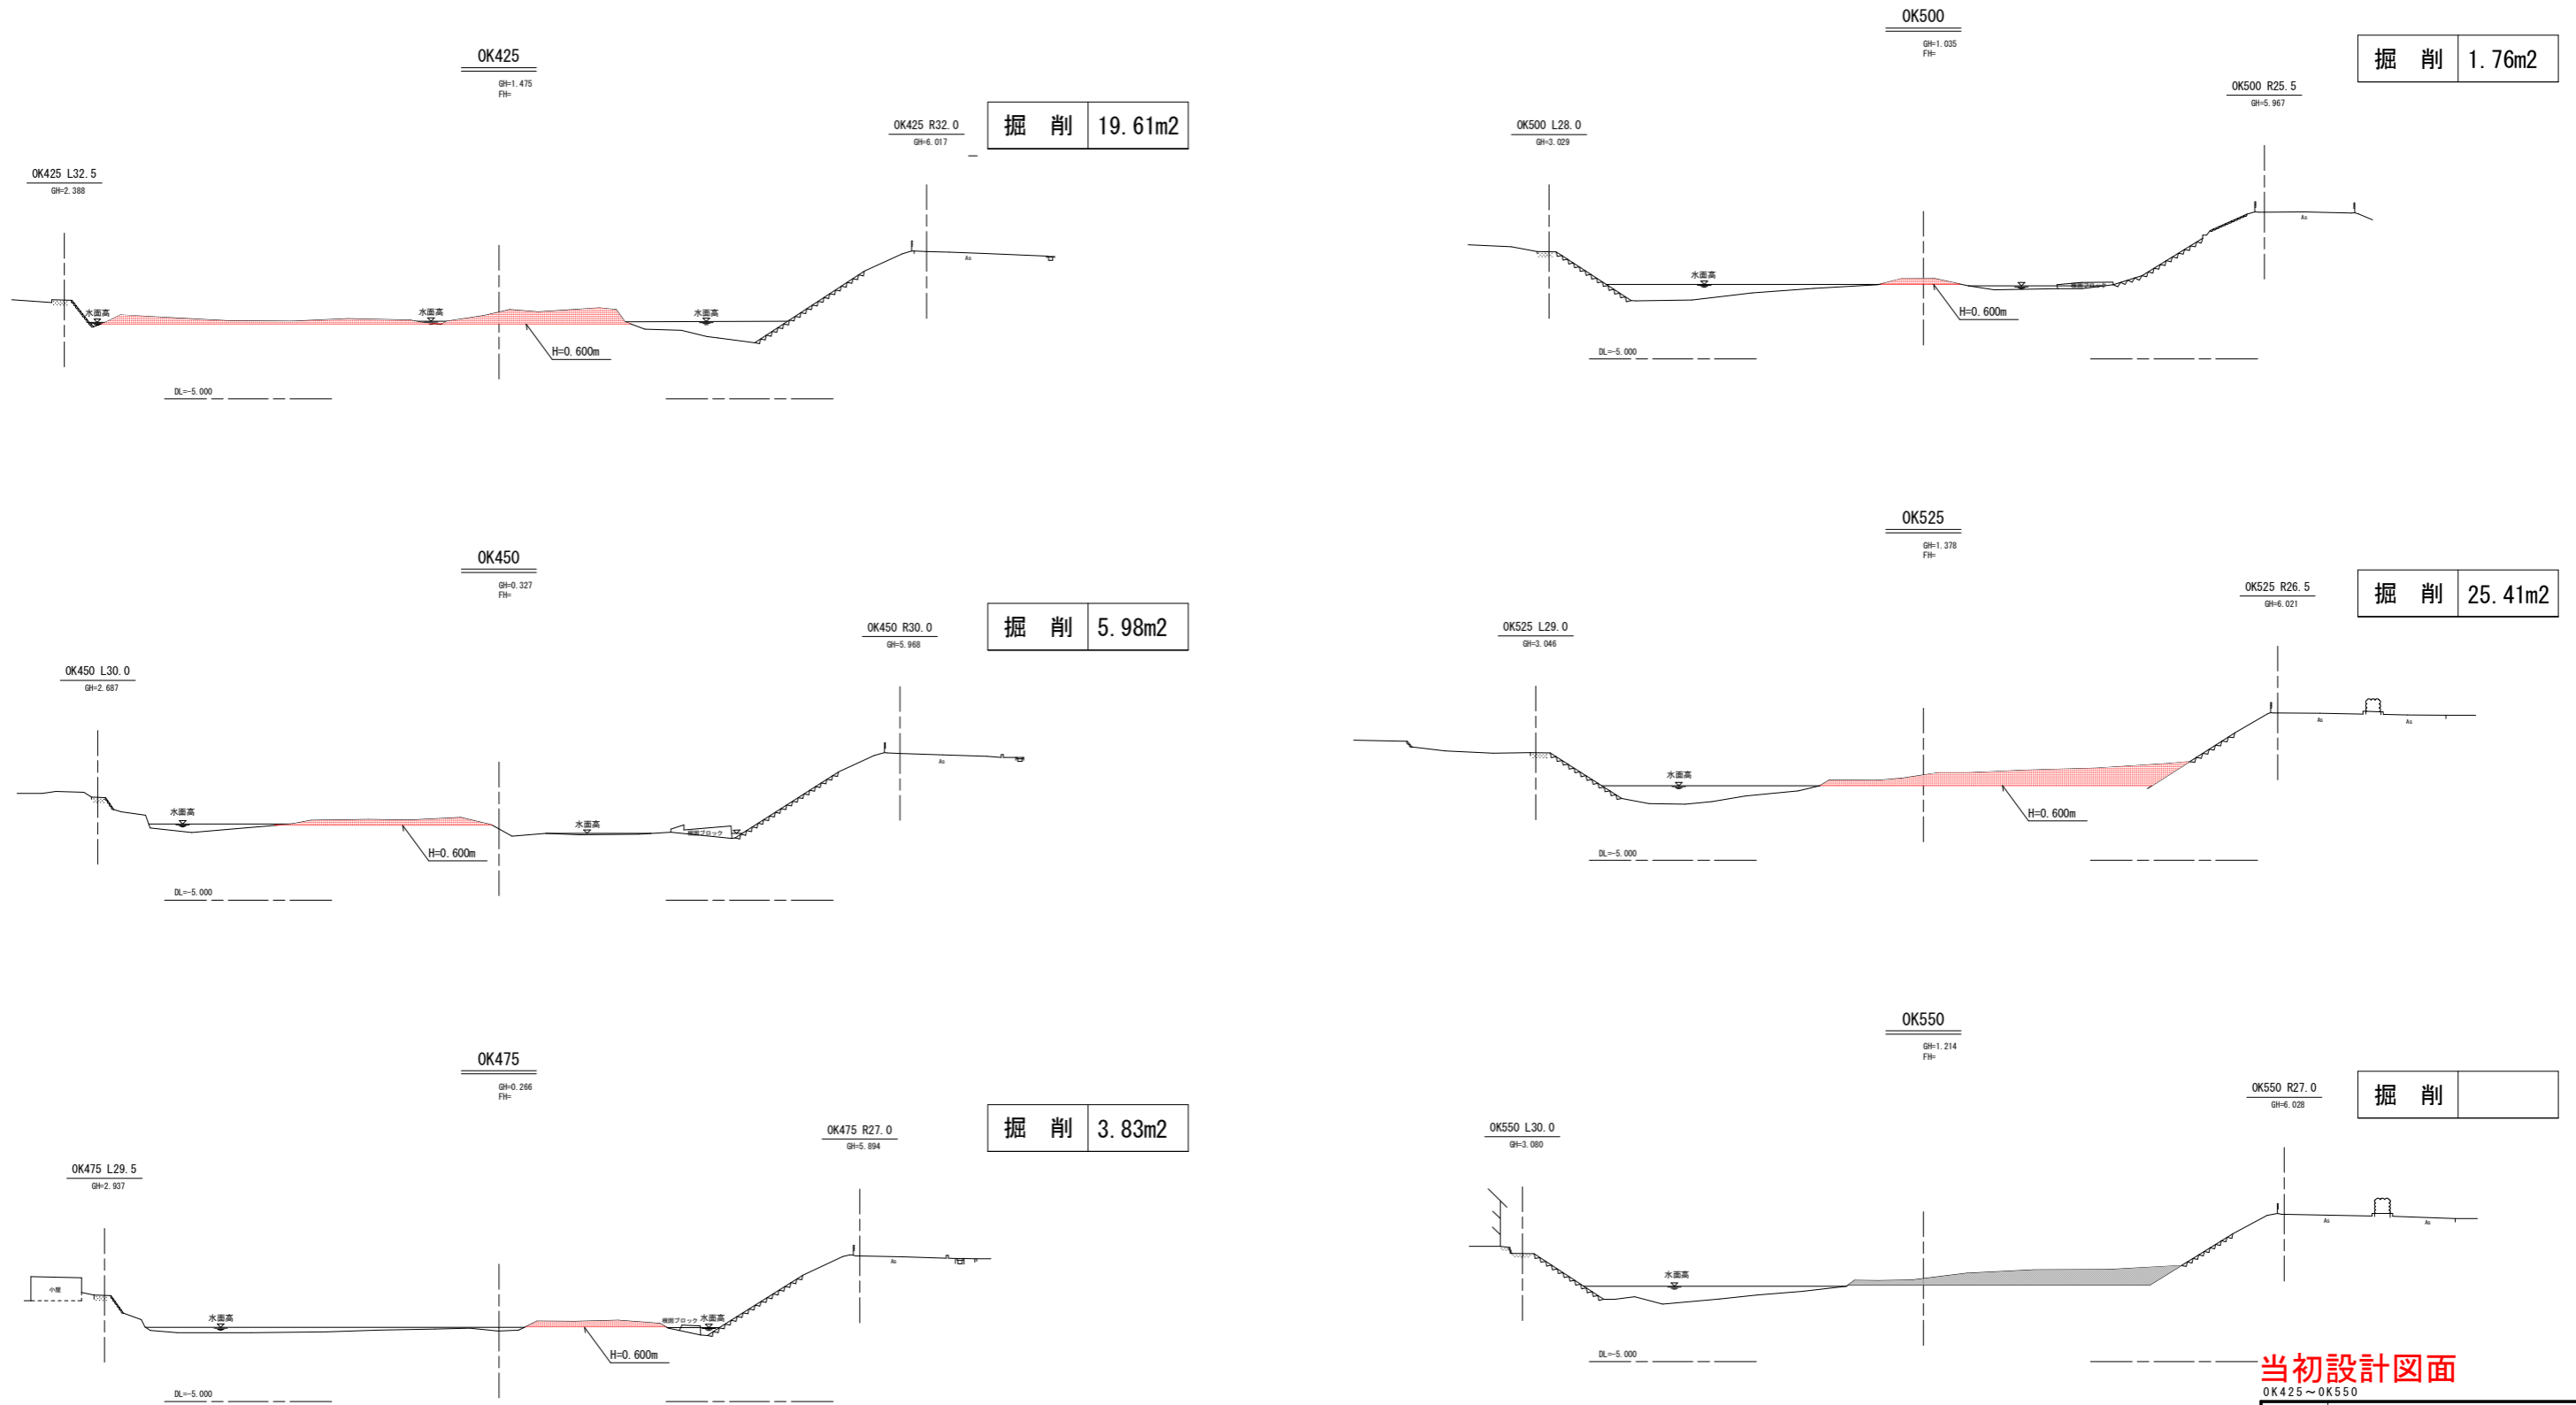

当初設計図面

| | |
|-------------|----------------------------|
| OK425~OK550 | |
| 工事名 | R2波土 北河内谷川 美波・北河内河床掘削工事(2) |
| 路線名等 | 北河内谷川 |
| 工事箇所 | 海部郡美波町北河内(第2分割) |
| 図面名 | 横断面図3 |
| 縮尺 | S=1:250 図面番号 5/7 |
| 会社名 | |
| 事業者名 | 徳島県南部総合県民局県土整備部(美波) |

横断面図 S=1:250

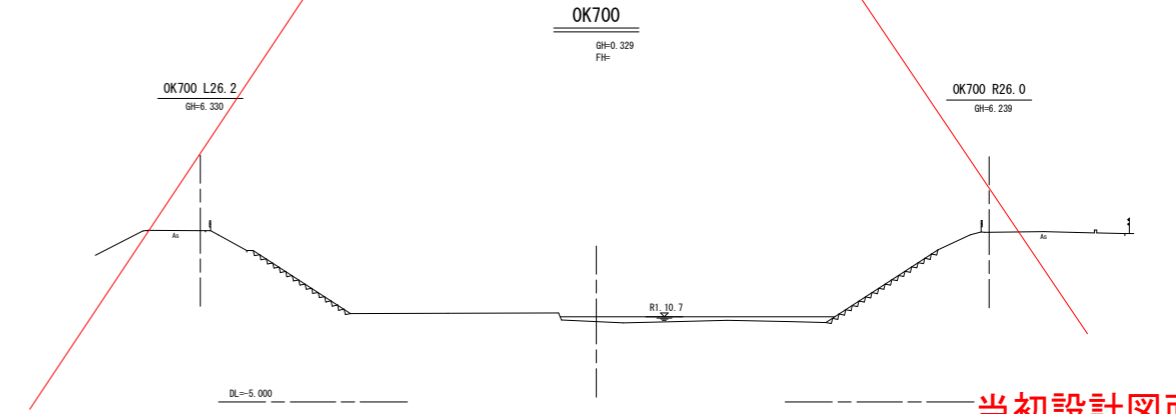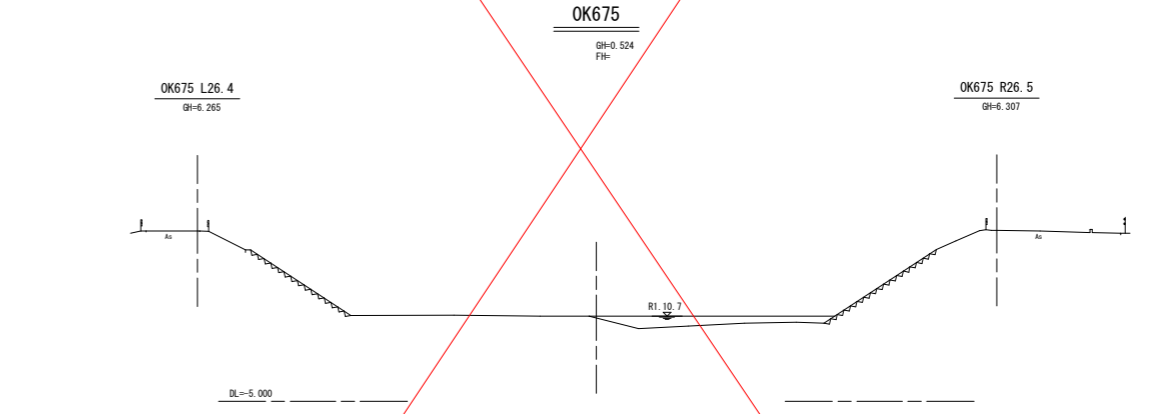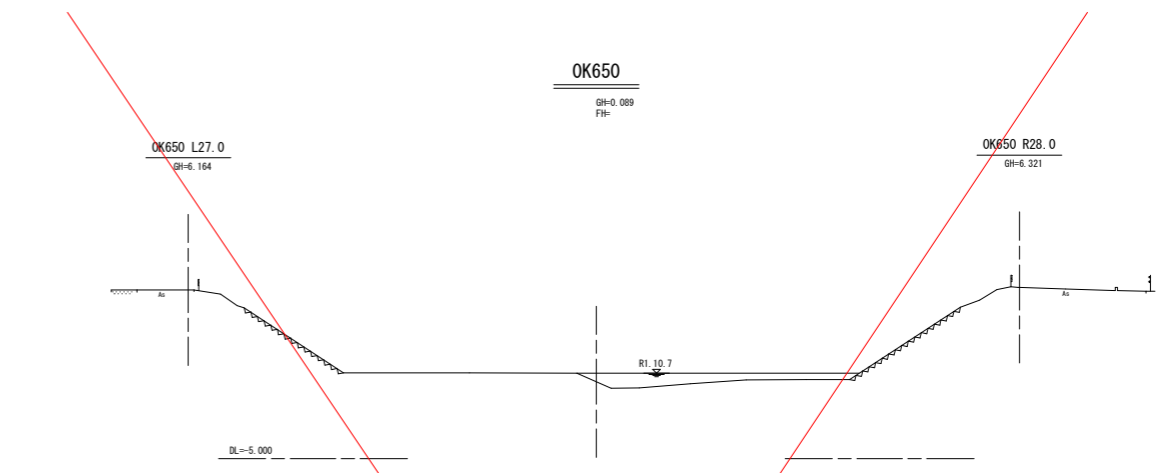
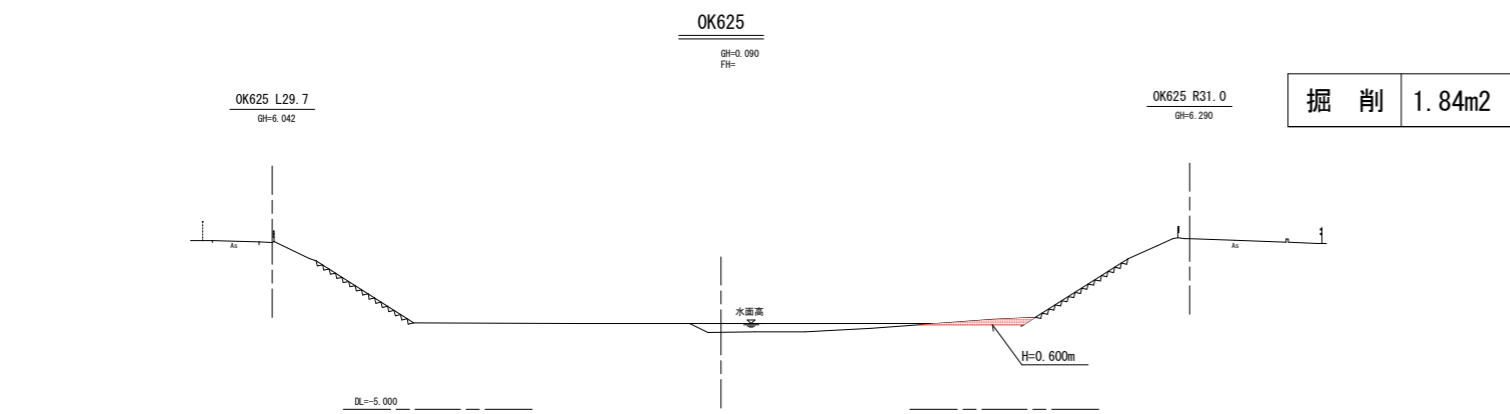
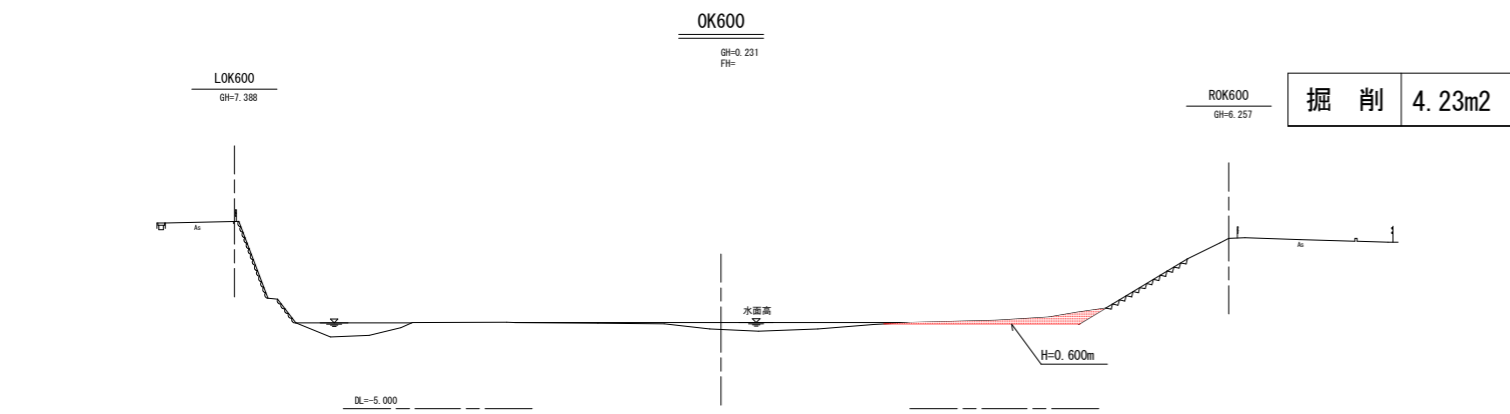
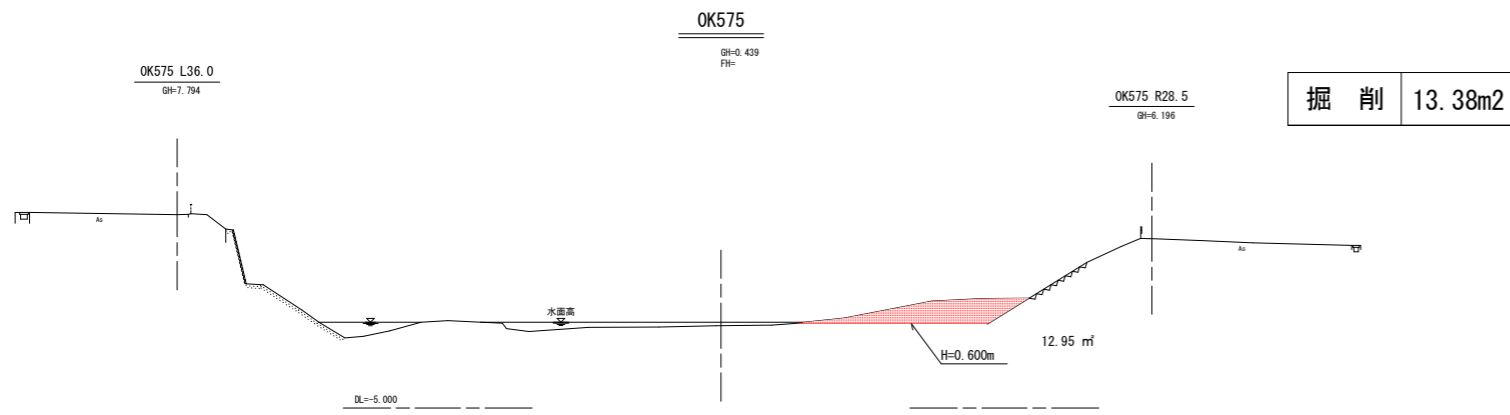


当初設計図面

| | |
|-------------|----------------------------|
| OK575~OK700 | |
| 工事名 | R2波土 北河内谷川 美波・北河内河床掘削工事(2) |
| 路線名等 | 北河内谷川 |
| 工事箇所 | 海部郡美波町北河内(第2分割) |
| 図面名 | 横断面図4 |
| 縮尺 | S=1:250 図面番号 6/7 |
| 会社名 | |
| 事業者名 | 徳島県南部総合県民局県土整備部(美波) |

仮設道路構造図 1:250

仮設道路工 L=49.21m 大型土のう設置 N=70個
 工事用道路盛土 V=593.4m³ 敷鉄板 A=74.3m²

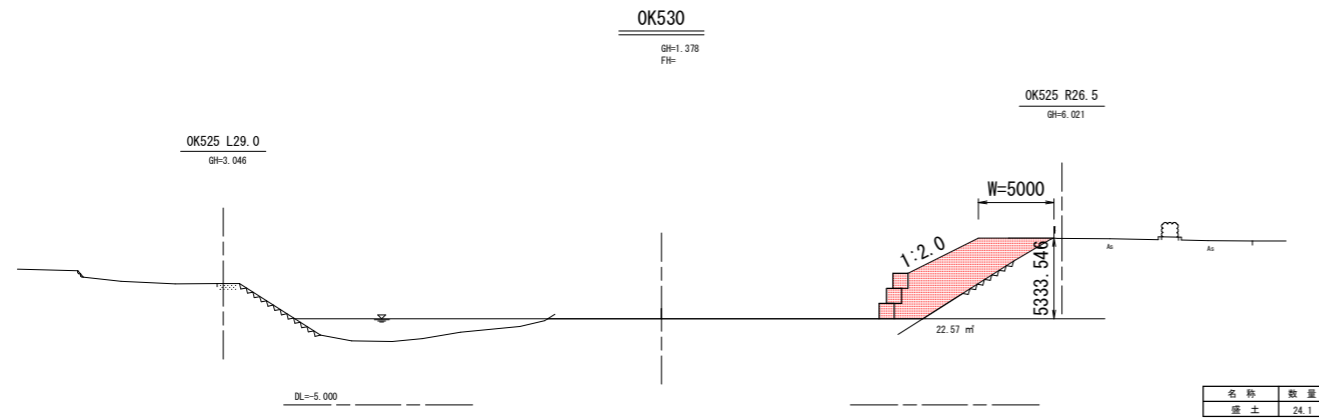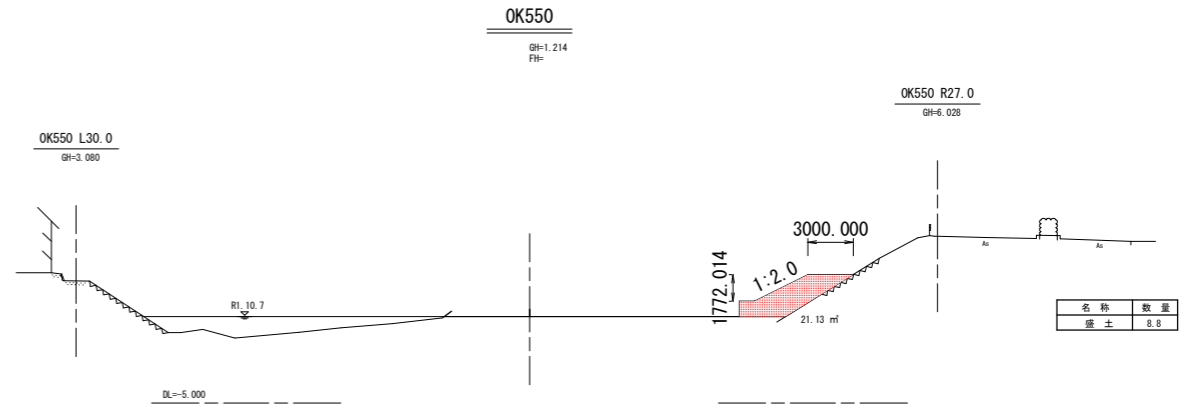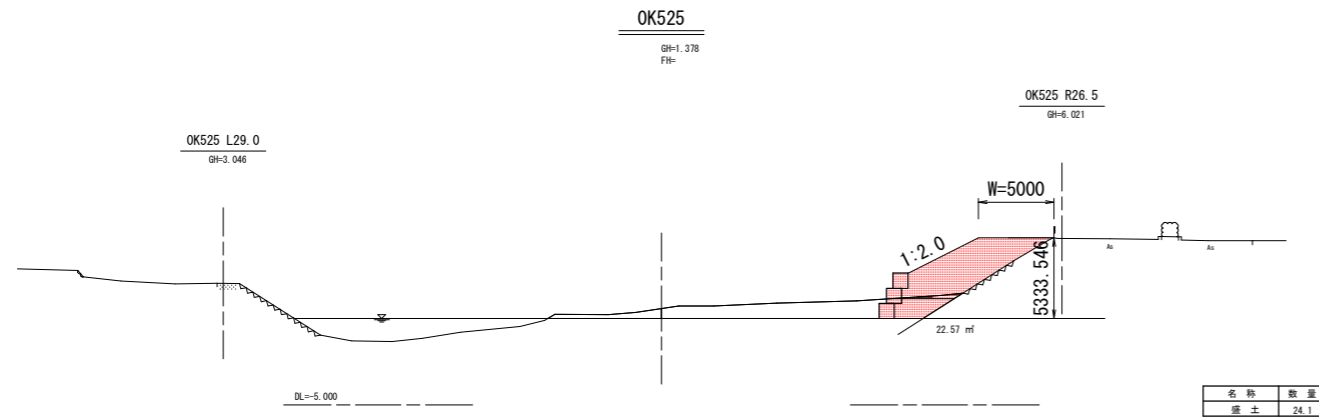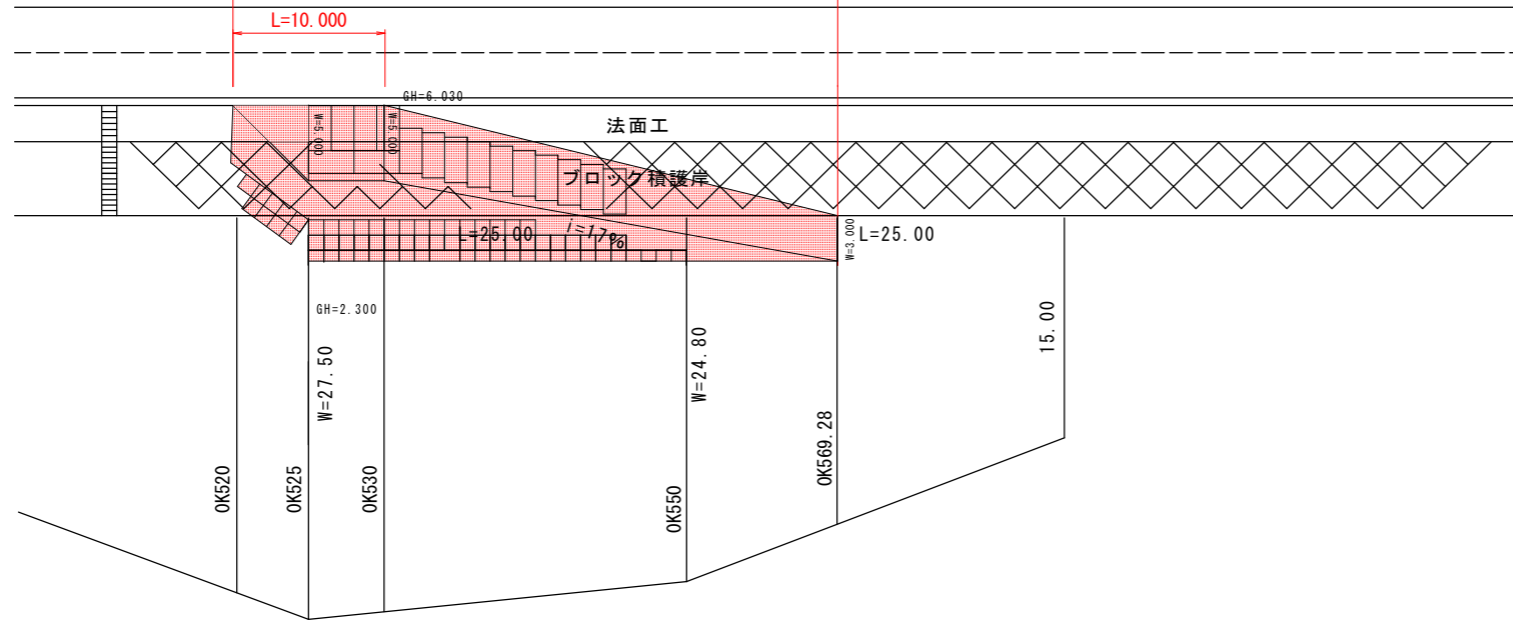

除草面積計算書

| 測点名 | 点間距離(m) | 断面(m ²) | 平均断面(m ²) | 数量(m ³) |
|-----------|---------|---------------------|-----------------------|---------------------|
| OK 520 | | 0.0 | | 0.0 |
| OK 525 | 5.0 | 24.1 | 12.05 | 60.3 |
| OK 530 | 5.0 | 24.1 | 24.1 | 120.5 |
| OK 550 | 19.93 | 8.8 | 16.45 | 327.8 |
| OK 569.28 | 19.28 | 0.0 | 4.40 | 593.4 |
| 合計 | 49.21 | | | 593.4 |

当初設計図面

| | | | |
|-------------|----------------------------|------|-----|
| OK575~OK700 | | | |
| 工事名 | R2波土 北河内谷川 美波・北河内河床掘削工事(2) | | |
| 路線名等 | 北河内谷川 | | |
| 工事箇所 | 海部郡美波町北河内(第2分割) | | |
| 図面名 | 仮設工 | | |
| 縮尺 | S=1:250 | 図面番号 | 7/7 |
| 会社名 | | | |
| 事業者名 | 徳島県南部総合県民局県土整備部(美波) | | |